

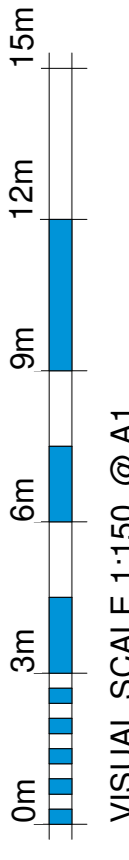


# Site Drainage Plan

1 : 150

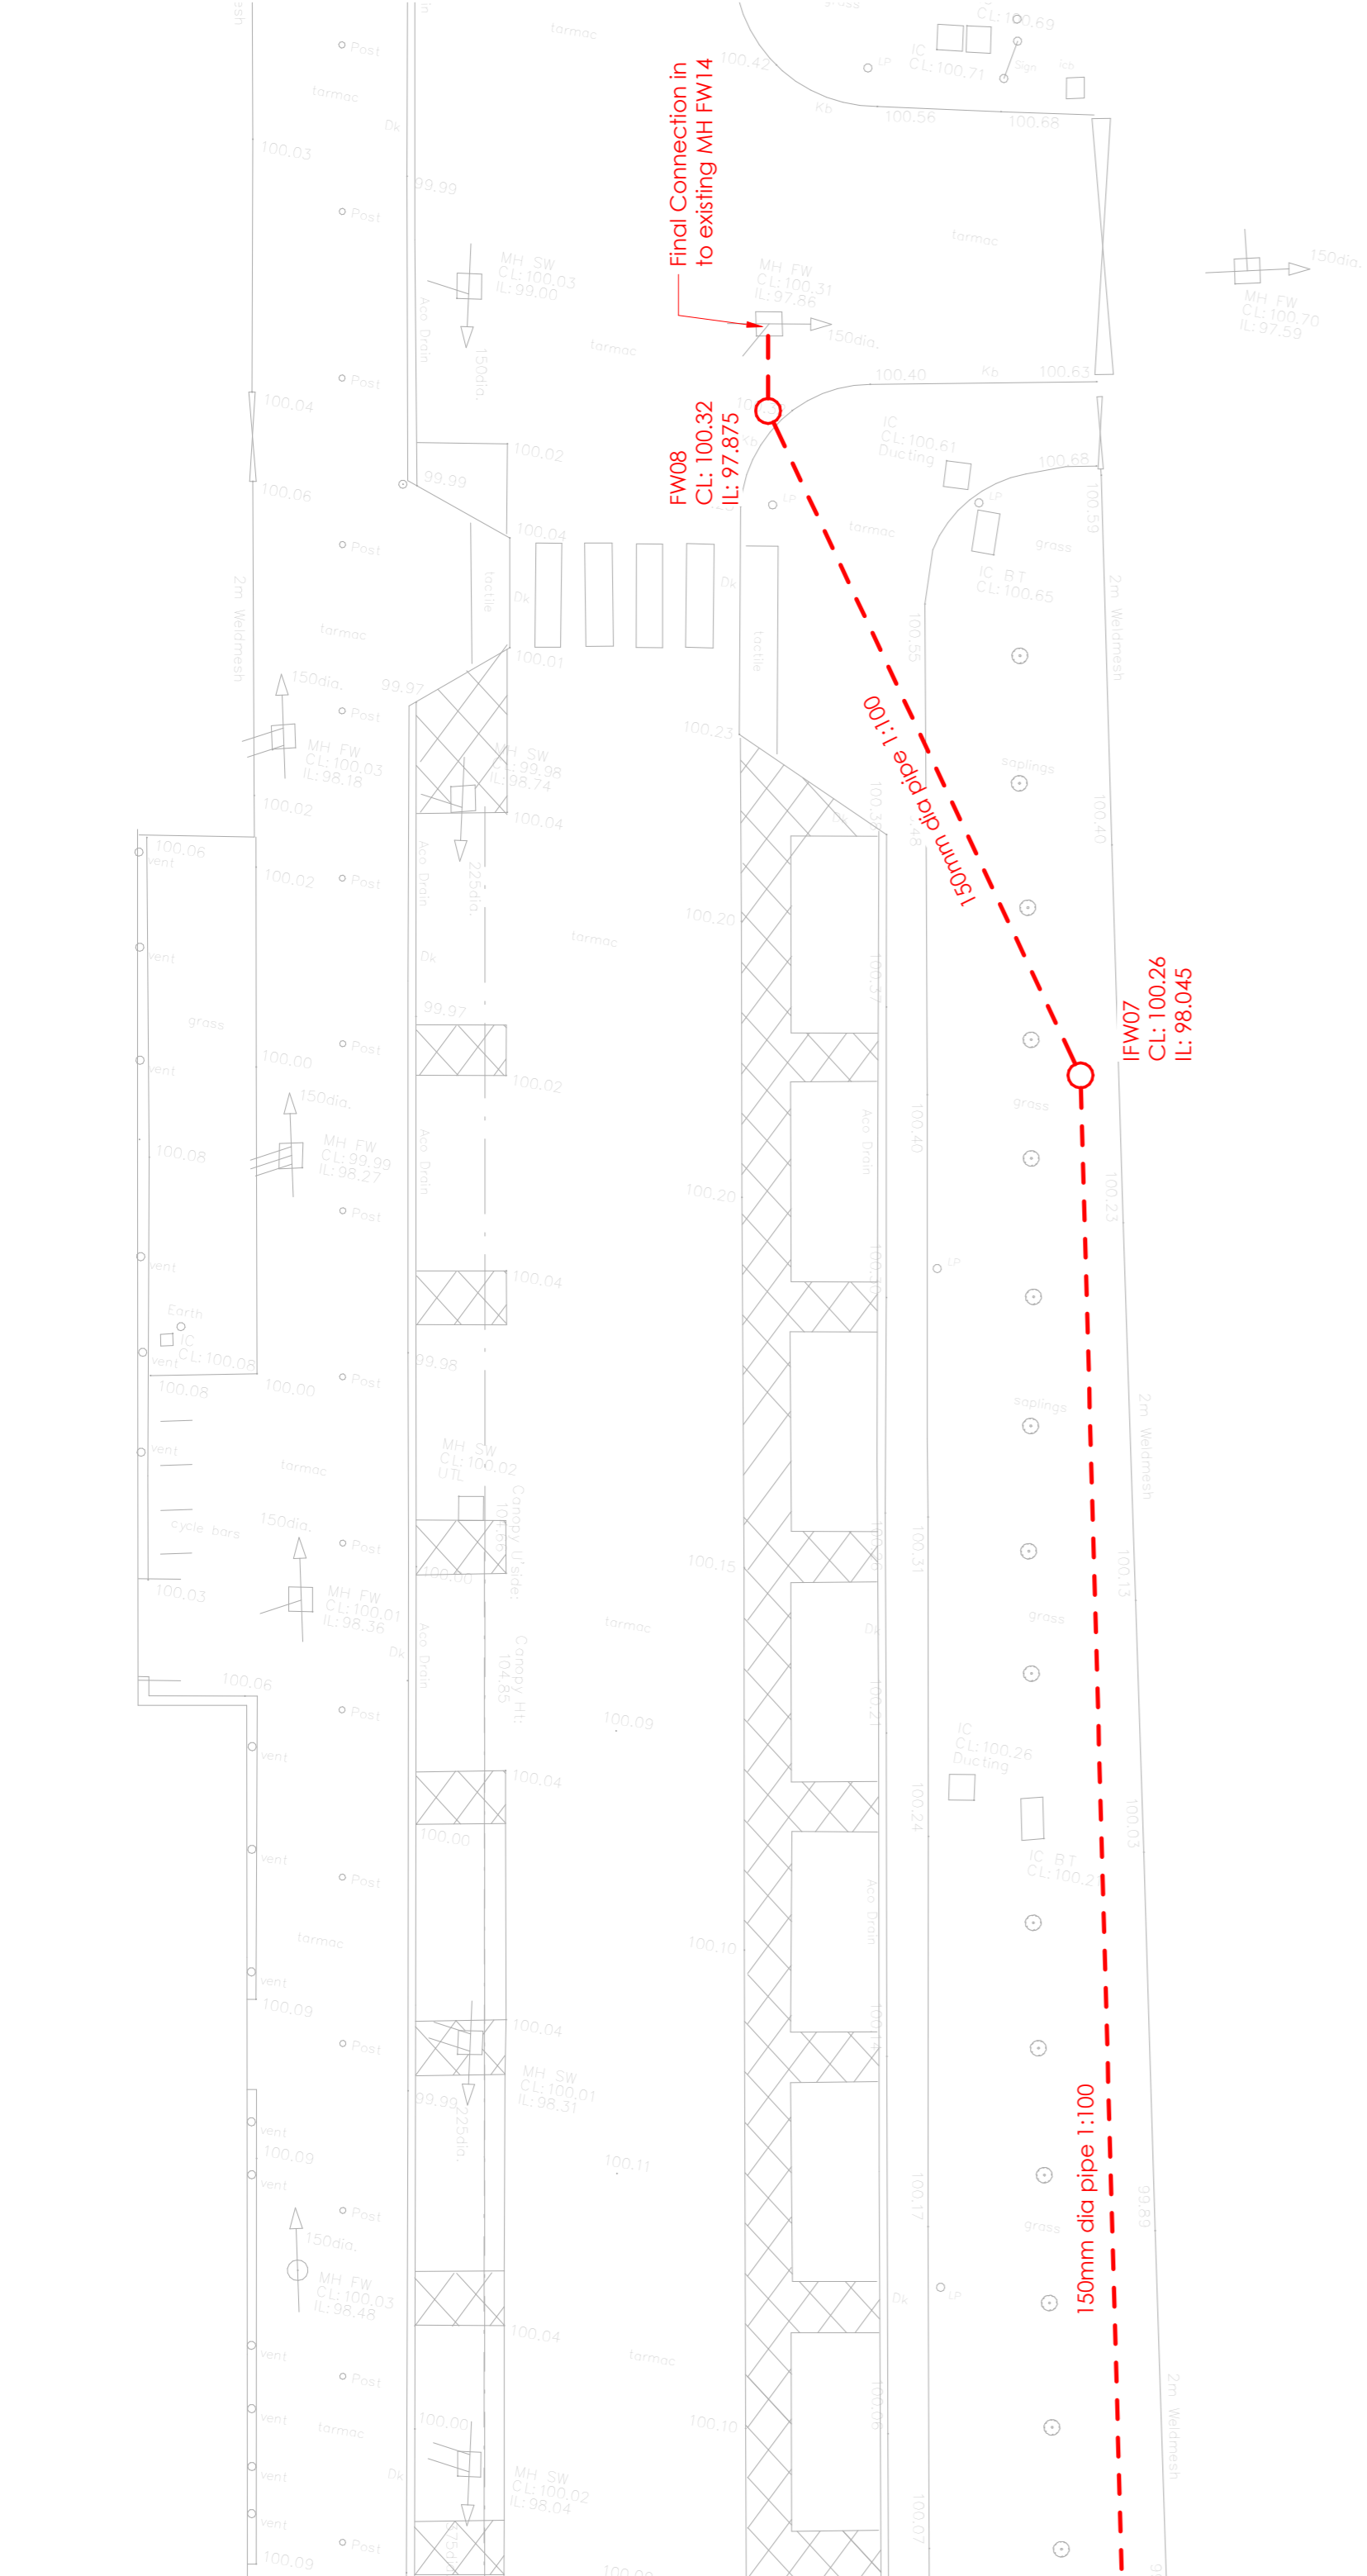

VISUAL SCALE 1:150 @ A1

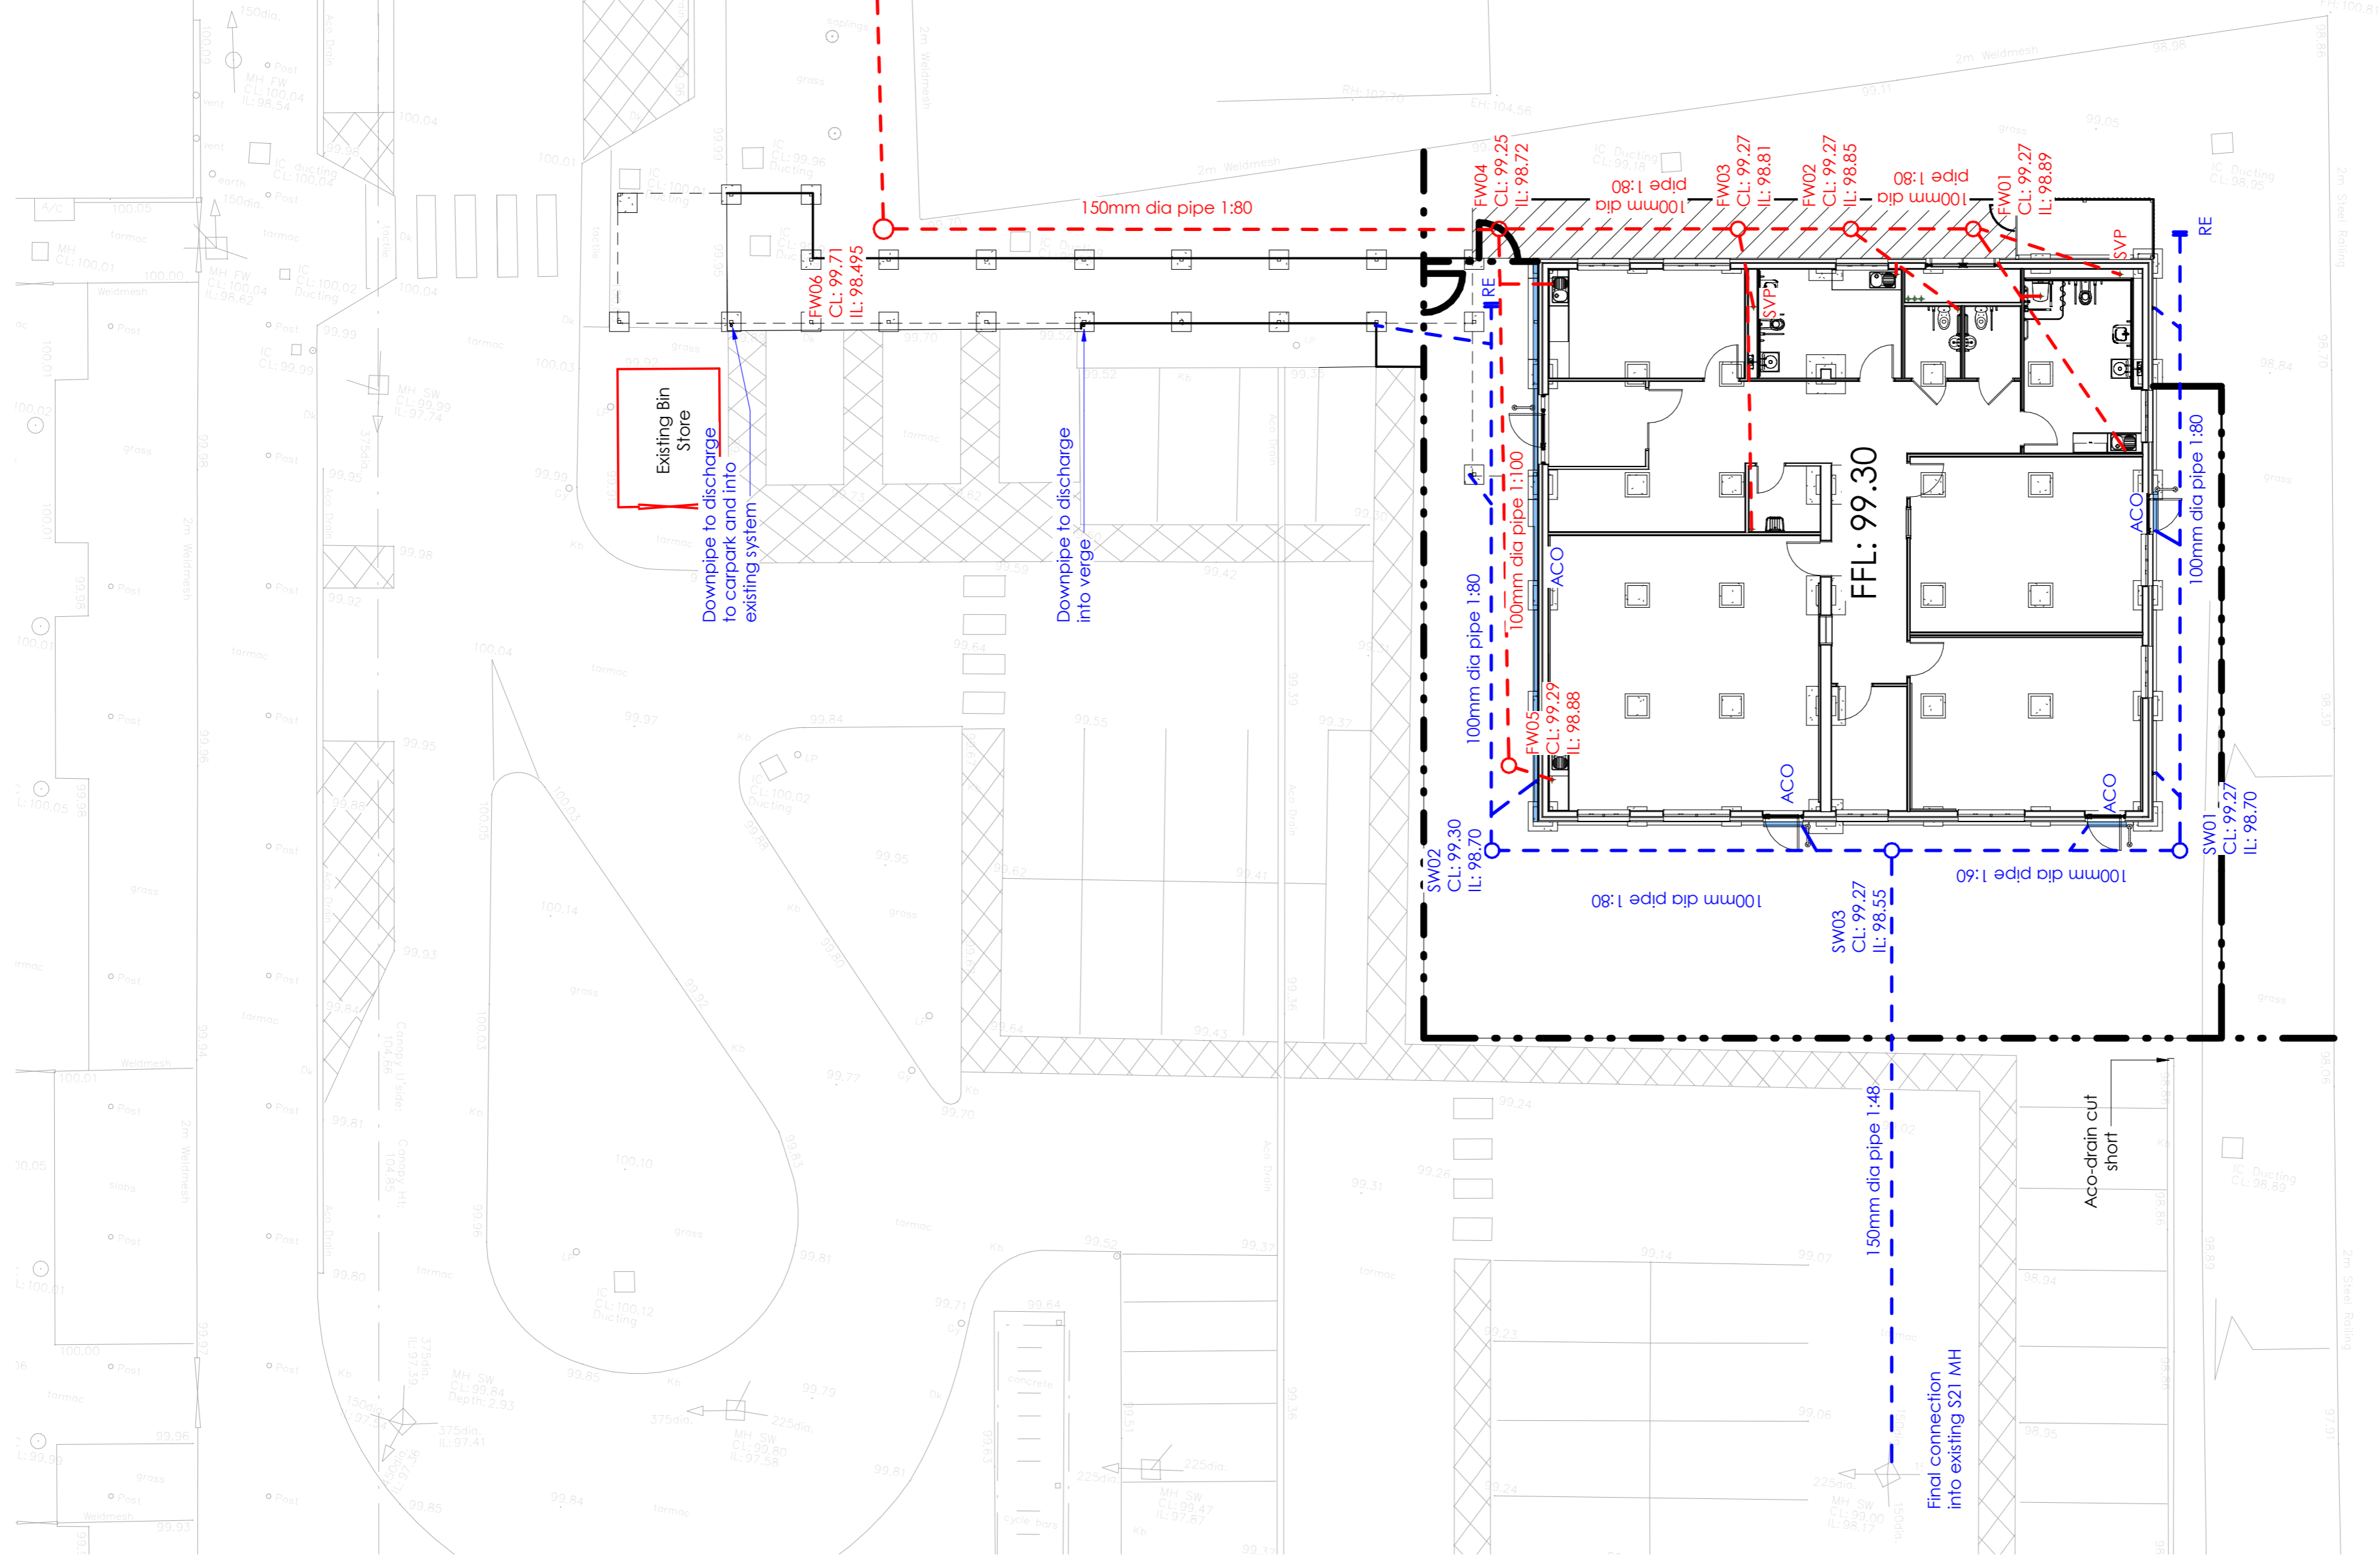

Red Kite Sixth Form Inspection Chamber Schedule

Ref	Chamber Details				Inspection Cover Details			
	Dia. (mm)	Type	Cover Level	Invert Level	Depth (mm)	Size (mm)	Load Class	Seal Type
FW01	450	PPIC	99.27	98.89	380	450 sq.	A15	Single
FW02	450	PPIC	99.27	98.85	420	450 sq.	A15	Single
FW03	450	PPIC	99.27	98.81	460	450 sq.	A15	Single
FW04	450	PPIC	99.25	98.72	530	450 sq.	A15	Single
FW05	450	PPIC	99.29	98.88	410	450 sq.	A15	Single
FW06	450	PPIC	99.71	98.495	1215	450 sq.	A15	Single
FW07	1200	PC	100.26	98.045	2215	600 sq.	A15	Single
FW08	1200	PC	100.32	97.875	2445	600 sq.	B125	Single
Existing F14	1200	PC	100.31	97.86	2450	600 sq.	B125	n/a
SW01	450	PPIC	99.27	98.7	570	450 sq.	A15	Single
SW02	450	PPIC	99.3	98.7	600	450 sq.	A15	Single
SW03	450	PPIC	99.27	98.55	720	450 sq.	A15	Single
Existing S21	1050	PC	99	98.17	830	600 sq.	B125	n/a

Rev	Description	By	Chk	Date
P2	CP Issue / Planning Issue.			30/06/2020
P3	Condenser enclosure moved 1.8m high w/ mesh inboard of main wall mesh + gate removed			22/07/2020

ALL DIMENSIONS ARE IN MILLIMETRES UNLESS OTHERWISE NOTED. DO NOT SCALE OFF DRAWINGS. ANY DISCREPANCIES WITH ANY INFORMATION PROVIDED, IT IS THE CONTRACTOR'S RESPONSIBILITY TO NOTIFY DARWIN GROUP LTD IMMEDIATELY.

**Darwin Group**  
Construction Ltd  
London House, Showbury  
Business Park, Showbury  
Brewsbury, ST4 4BA  
TEL: 01939 232900  
www.darwingroup.co.uk

PROJECT TITLE  
Red Kite Academy  
ADDRESS  
Copy  
NN18 0BY

DRAWING TITLE  
Proposed Drainage Plan

DRAWING REFERENCE  
180235\_DGL\_01\_XX\_DR\_A\_1200

PROJECT DISCIPLINE  
17/05/20  
TM  
INITIAL CHECKED BY  
303 m<sup>2</sup>  
SHEET REV  
A1 P3

SUITABILITY  
S2 For Information  
SCALE  
1 : 150  
SHEET REV  
A1 P3